BASIX Commitments

Basix Certificate No:1011622S

HOT WATER

Gas Instantaneous -6.0 star

VENTILATION

- Bathrooms/toilet: Individual fan ducted to facade or roof with interlock to light switch
- Kitchen: individual fan, not ducted with manual ON /OFF
- Laundry: No Mechanical Ventilation

AIR CON:

• Cooling & Heating: 1-phase Air conditioning (EER 2.5-3.0)-Zoned

LIGHTING

· Energy efficient light fittings (LED or fluorescent for each individual spaces)

KITCHEN

· Gas cooktop & electric oven

CLOTHES DRYING LINE

- No, Indoor Clothes drying line
- Yes, outdoor clothing drying line

WATER SAVING

- 3 star shower heads
- 3 star toilets or better
- 4 star kitchen tap
- 4 Star bathroom tap

RAIN WATER&STORM WATER TANK:

• 2000 L rain water tank used for landscape .

Assessor Certificate

Issued in accordance with BASIX Thermal Comfort Simulation Method.

Assessor No # 20851 Projects: BARDIA Thermal performance specifications

Following specification must apply to all instances of that element for the whole project. If different construction elements are applied then the Assessor Certificate is no longer valid.

Certificate No: 000380402	28	4 RETIMO STREET	
External walls Construction	on	Added Insulation	
75mm Hebel cavity panel		R1.5	
Internal walls Constructio	n		
Plasterboard on studs		R1.5	
Roof Construction			
Metal roof		Nil	
Colour		Medium	
Ceilings Construction			
Plaster board		R3.5	
Floors Construction	Covering		
Concrete (on ground)	As drawn	Nil	
Timber(floor between)	As drawn	Nil	
Timber(above garage) As drawn		R3.5	
Windows/Doors			

All window and glazed door to be selected as per AFRC. Deviation is accepted ±5%. : This tolerance ONLY applies to SHGC, the U-value car always be lower but not higher than the values stated.

Area (M²)	Frame		Ext. cover	U	Val	SHGC	Glazing
As drawn	Alum/slidi	ng	As drawn	6.	7	0.70	Single clear
As drawn	Alum/Awr	ning	As drawn	6.	7	0.57	Single clear
Skylights	Skylights						
Area (M ²)	Area (M ²)		Туре		Glaz	Glazing	
As drawn	As drawn		Nil		Nil	Nil	
Fixed sha	Fixed shading (eaves, pergolas, verandas , awnings)						
All shade	All shade elements modelled as drawn						
Weather s	Weather seals to windows				Be	e provide	d
All down l	All down lights be sealed				Ye	S	



Assessor Name: Mahbub Hassan Accreditation no.: 20851 5.2 Certificate date: NATIONWIDE Owelling Address: 4 RETIMO STREET BARDIA, NSW 107.2 MJ/m² 2565

www.nathers.gov.au

Certificate no.:



0003804028

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LOT 2022/-/DP1200782

Shee	et List Table	SPEC
Number	Sheet Title	REFE
A101	COVER SHEET AND NOTES	1.
A102	SITE PLAN AND COMPLIANCE TABLE	2. 3.
A103	PROPOSED GROUND FLOOR PLAN	4.
A104	PROPOSED FIRST FLOOR PLAN	5.
A105	ELEVATIONS (1)	6.
A106-	ELEVATIONS (2)	7.
A107	SECTIONS	8. 9.
A110	SCHEDULES	9. 10.
A111	NOTIFICATION PLAN	11.
A201	SITE ANALYSIS PLAN	12.
A202	DRAINAGE CONCEPT PLAN	13.
A203-B	SHADOW DIAGRAMS	14.
A203-A	SHADOW DIAGRAMS	15. 16.
A204	ROOF PLAN	17.
A205	CONSTRUCTION MANAGMENT PLAN	18.
A206	LANDSCAPING CONCEPT PLAN	19.
A207	CONCRETE LAYOUT	20.
		21.
		22. 23.
		J.


17.	SMOKE A
18.	HEATING
19.	BUSHFIRE
20.	WET ARE
21.	LIGHTING
22.	ROOM VE
23.	PROTECT
24.	STAIRS, I
25.	SLIP RES
26.	ENERGY

4 RETIMO STREET, BARDIA, 2565

CONSTRUCTION OF A TWO STOREY DWELLING

<u>CIFICATIONS OF BUILDING WORKS (SUMMARY):</u> ER DETAILED SPECIFICATIONS ATTACHED TO CC PLANS EARTHWORKS AND EXCAVATIONS: AS3798. OR AS/NZS3500. TERMITE MANAGEMENT SYSTEM: NCC VOL. 2 PART 3.1.3 DRAINAGE WORK SHALL COMPLY WITH PART 3.1.2 OF NCC VOL.2 AND AS3500. FOOTINGS AND SLABS: AS PER BCA VOL.2 PART 3.2.5. CONCRETE /STRUCTURAL CONCRETE : VOL. 2 PART 3.2.3 AND AS3600, BRICK AND BLOCKWORK: AS3700 OR AS4773 SUBFLOOR VENTILATION: IN ACCORDANCE WITH VOL. 2 PART 3.4.1 TIMBER FRAMING: NCC VOL. 2 PART 3.4.3 TO COMPLY WITH AS1684. STEEL CONSTRUCTION, NCC VOL.2 PART 3.4.2, AND NCC VOL.2 PART 3.4.4 WALL AND FLOOR TILES: AS3958 PARTS 1 AND 2. ROOFING - NCC VOL. 2 PART 3.5.1, CONCRETE TILES: AS2049, AS4046 AND AS2050 FIXING ROOF TILES: NCC VOL. 2, FIG. 3.5.1.1 WALL CLADDING TO COMPLY WITH PART 3.5.3 OF NCC 2016 VOL. 2 EAVE AND SOFFIT LININGS TO COMPLY WITH NCC VOL. 2 PART 3.5.3.5 GLAZING: NCC VOL. 2 PART 3.6 ALARM AS PER AS 3786-1993 AND PART 3.7.2 OF NCC 2016 VOL. 2. APPLIANCES NCC VOL 2 PART 3.7.3 RE PRONE AREAS NCC VOL. 2 PART 3.7.4. EAS: NCC VOL. 2 PART 3.8.1 ; NCC VOL. 2 PART 3.8.4.2 ENTILATION: PART 3.8.5.2 FION OF OPENABLE WINDOWS: (AGAINST FALLING) NCC VOL.2 PART 3.9.2.5 HANDRAILS AND BALUSTRADES: NCC VOL. 2 PARTS 3.9.1 AND 3.9.2 SISTANCE: TO COMPLY WITH PART 3.9.1.4, AS4586 AND HB198. EFFICIENCY : NCC VOL. 2 PART 3.12 27. EXTERNAL GLAZING: NCC VOL. 2 PART 3.12.2 28. HOT WATER SERVICE: AS3500.4 29. GAS INSTALLATIONS: 'GAS SAFETY REGULATIONS AND ACT' AND AS5601.


Drawing Title: C	OVER SHEET AND NOTES		
Date	Scale	Drw no	Revision
23/04/2019	AS NOTED @ A3	A101	A

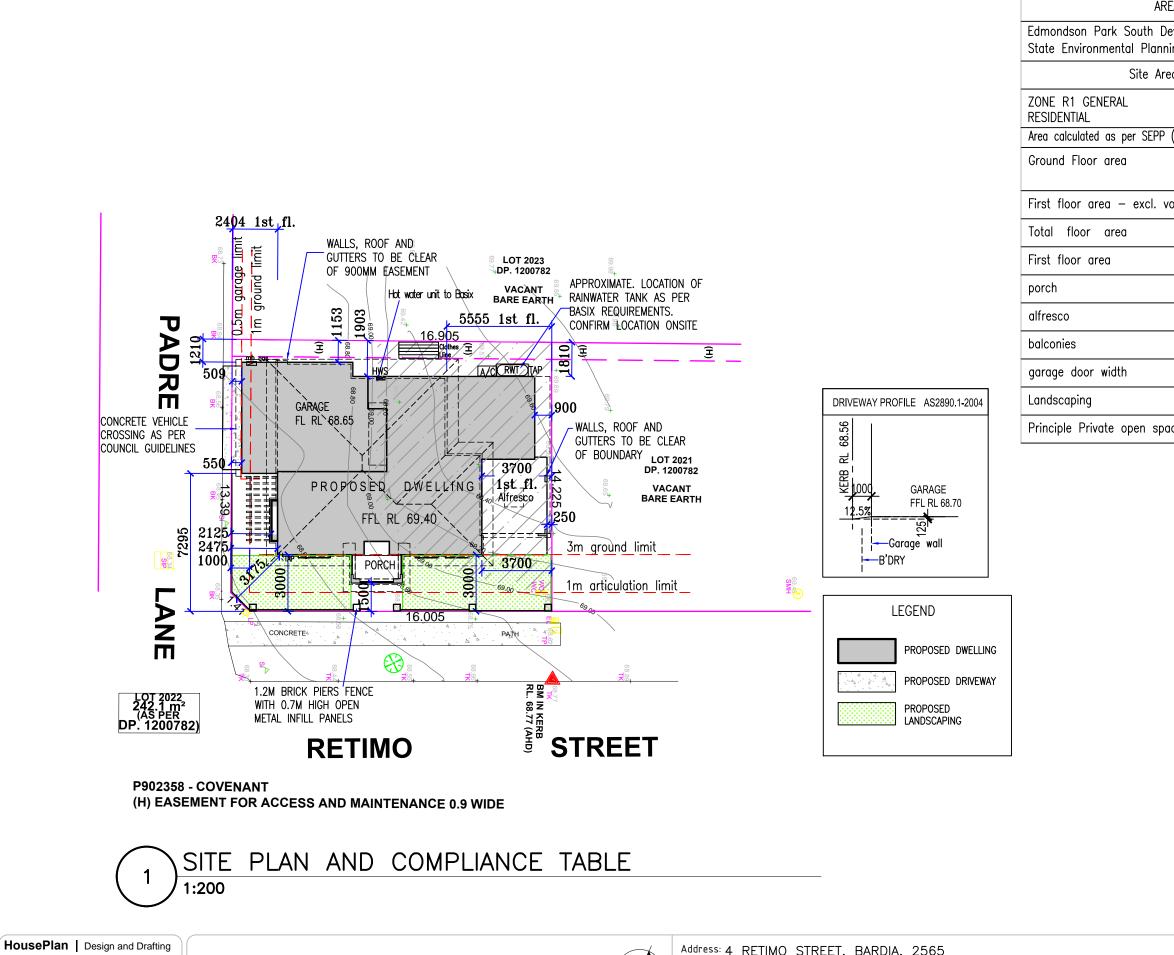


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SCHEDULE AND COMPLIA	ANCE	
242.1 m²		
Provided	Control	Compliance
empt and Complying Develo	opment Codes) 2008	
127.3 (53%) site coverage	max. 65% site coverage	YES
90.5		
217.8 FSR 89.9%	max. FSR 90%	YES
117.56		
5		
14		
8		
5m	6m	YES
40 (min.) 16.5%	10% Min.	YES
25 min3.6m wide	16 Min.—3m wide	YES
	opment Control Plan 24 Policy (State Significan 242.1 m ² Provided mpt and Complying Develor 127.3 (53%) site coverage 90.5 217.8 FSR 89.9% 117.56 5 14 8 5m 40 (min.) 16.5%	Provided Control empt and Complying Development Codes) 2008 127.3 (53%) site coverage 127.3 (53%) site coverage max. 65% site coverage 90.5 217.8 FSR 89.9% 117.56 5 5 1 14 1 8 5 5m 6m 40 (min.) 16.5% 10% Min.


Drawing Title: S	ITE PLAN AND COMPLIANCE	TABLE	
Date	Scale	Drw no	Revision
27/04/2019	AS NOTED @ A3	A102	Α

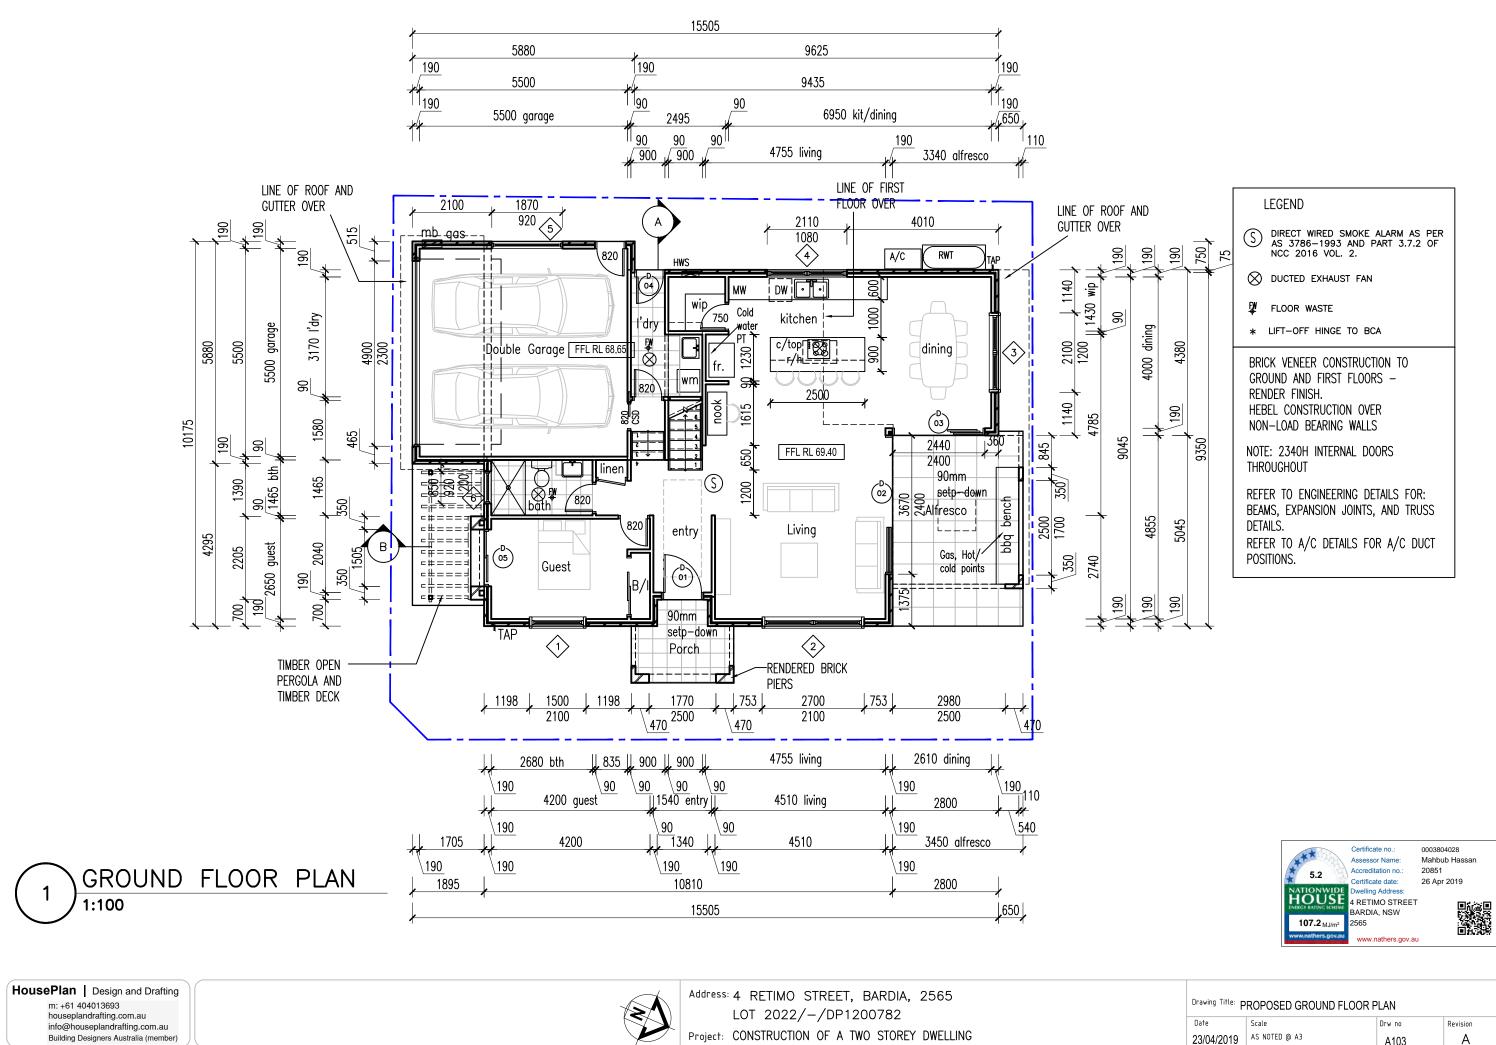

Drawing Title: P	ROPOSED GROUND FLOOR F	PLAN	
Date	Scale	Drw no	Revision
23/04/2019	AS NOTED @ A3	A103	A

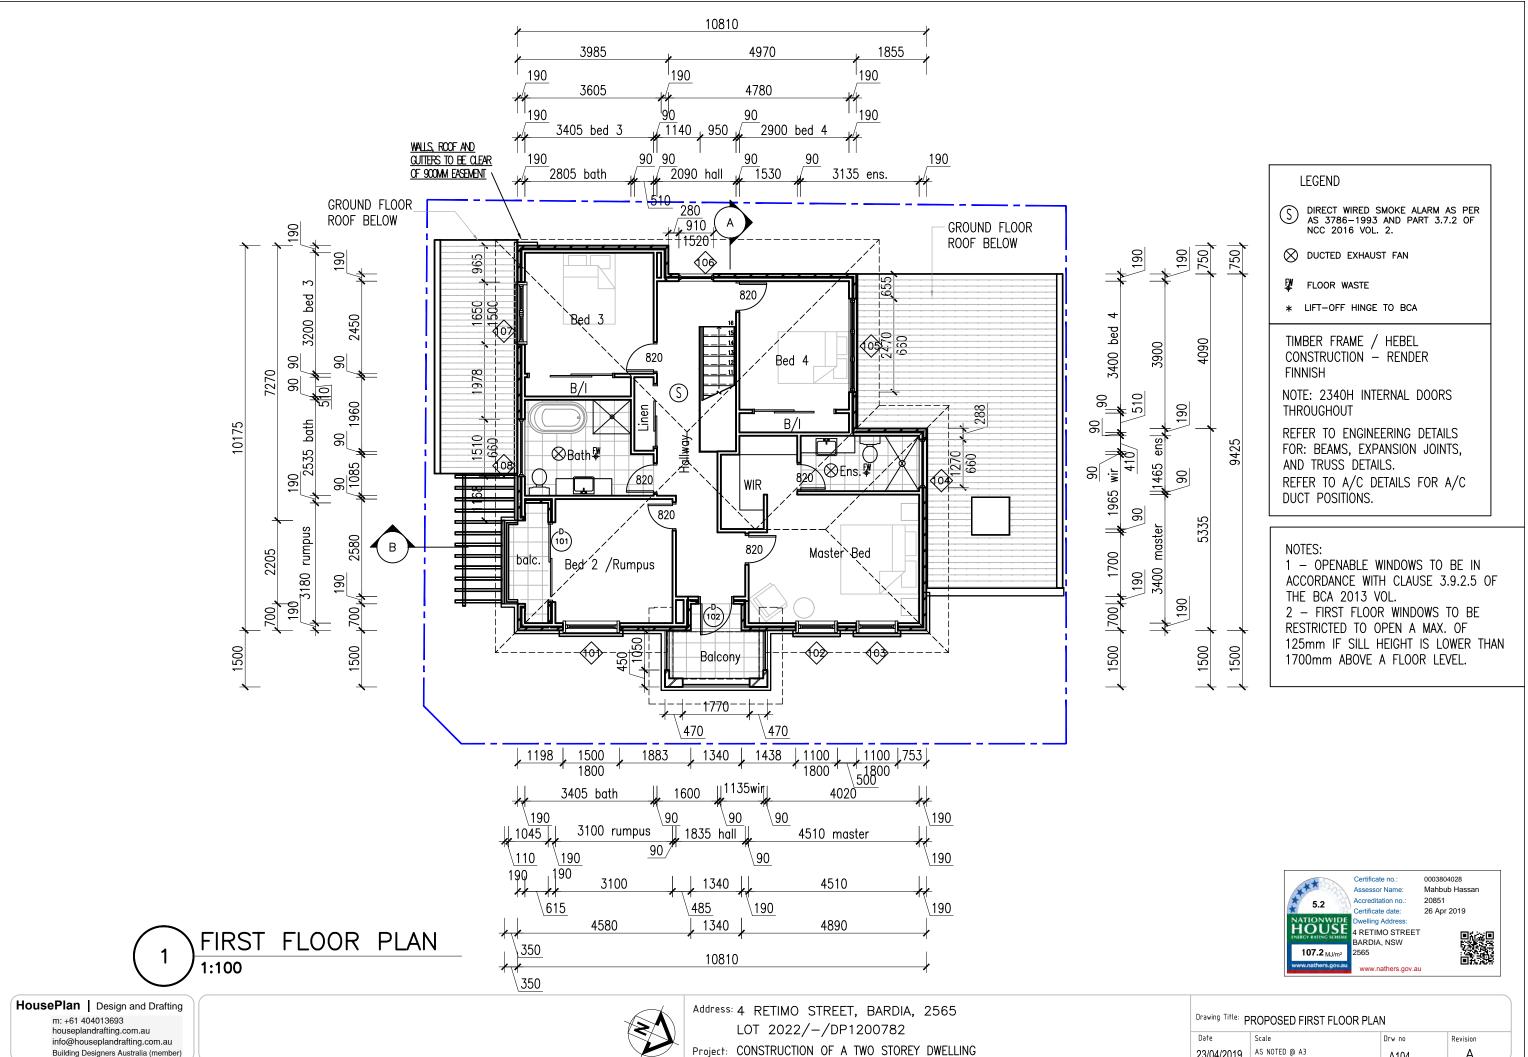

Drawing Title: P	ROPOSED FIRST FLOOR PLA	N	
Date	Scale	Drw no	Revision
23/04/2019	AS NOTED @ A3	A104	A

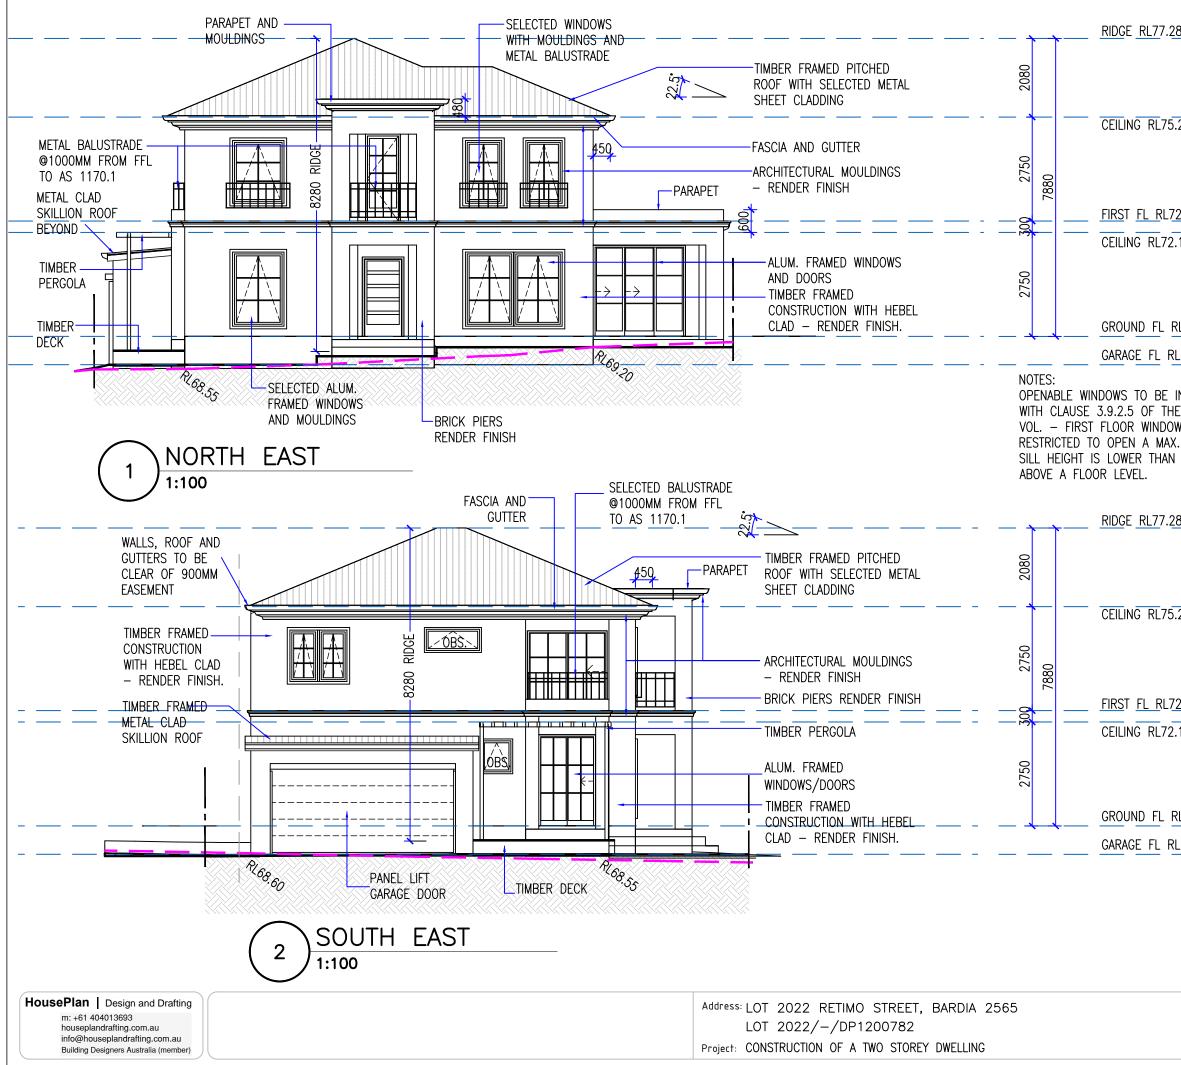

3	-		
20	-		
.45 15	-		
.69.40	-		
58.65	-		
ACCORDANCE BCA 2013 S TO BE OF 125mm IF 1700mm			
	-		
0	-		
. <u>45</u> 5	-		
.69.40	-		
68.65	-		
	5.2 NATIONU INECY FAILOR	Certificate no.: Assessor Name: Accreditation no.: Certificate date: Dwelling Address: 4 RETIMO STREET BARDIA, NSW 2565	0003804028 Mahbub Hassan 20851 26 Apr 2019

Date

Scale


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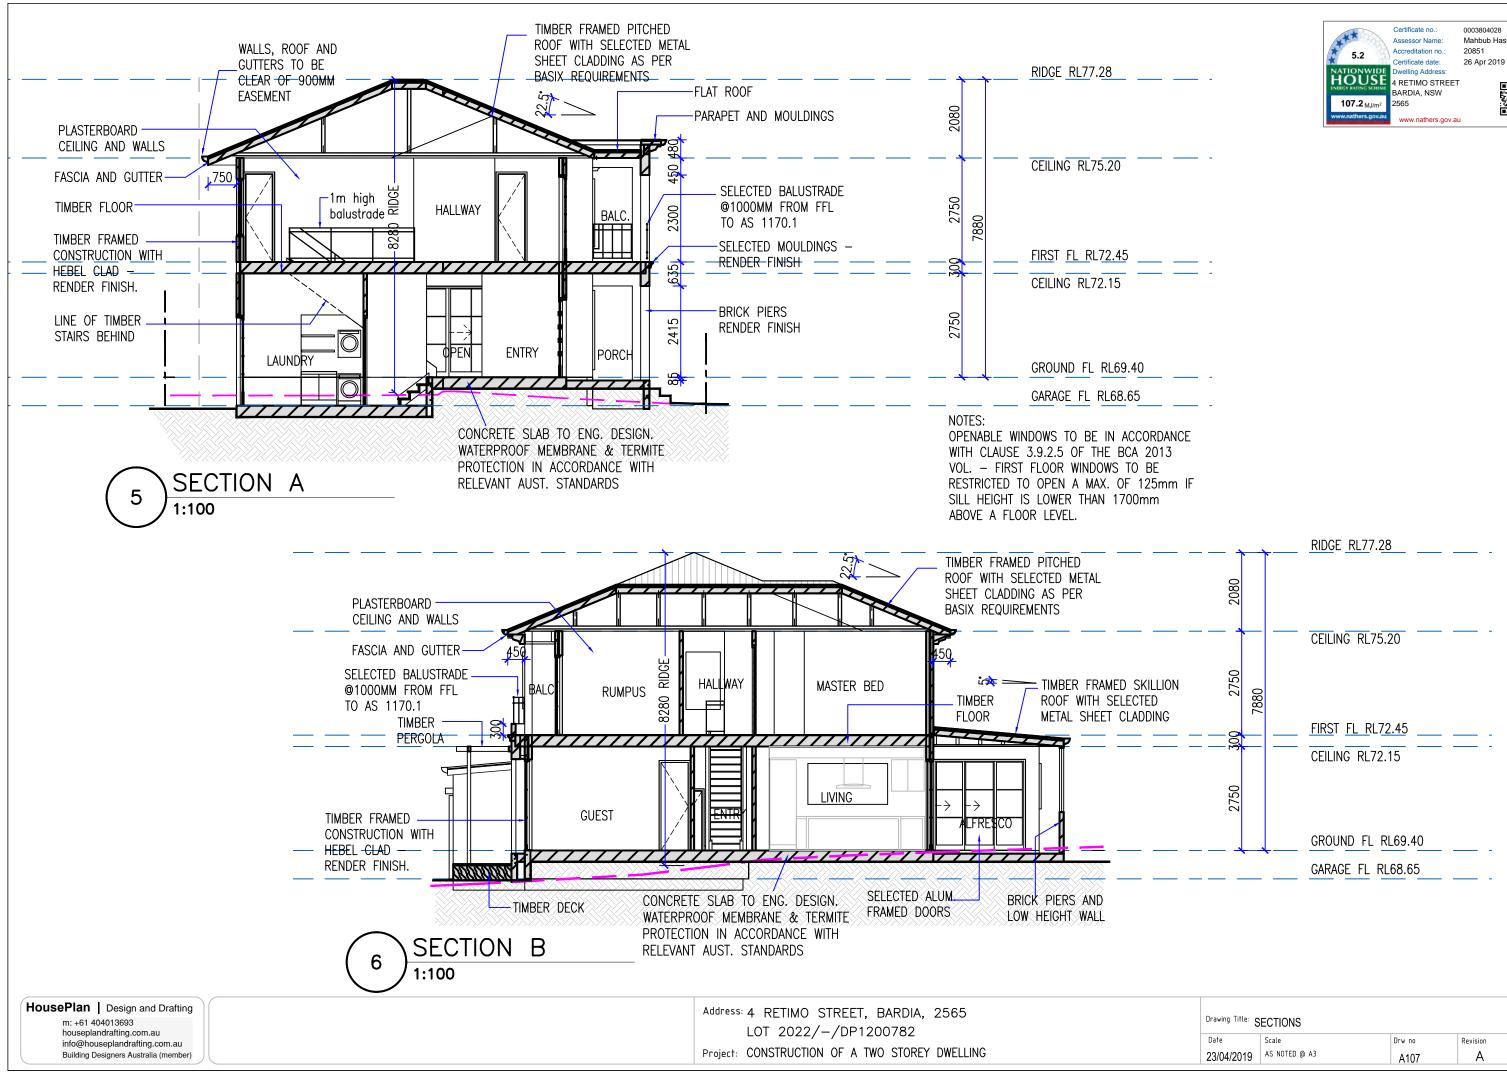
A105

Revision

А



	<u>RIDG</u> E	<u>RL7</u> 7.2 <u>8</u>					
	CEILING	RL75.20					
		EL RL72.45	=	:			
	GROUNI	D FL RL69.	40		_		
	GARAGE	E FL RL68.6	5				
LAUS FIRS CTED EIGHT	E 3.9.2.5 ST FLOOR TO OPEN	O BE IN AC OF THE BC WINDOWS T A MAX. OF 2 THAN 170 L.	A 2013 O BE 125mm				
	RIDGE	RL77.28					
	<u>FIRS</u> T F	RL75.20 <u>L RL72.45</u> RL72.15	:	:			
.		<u>) FL RL69</u> .					
	GARAGE	E FL RL68.6	65				
				5.2 ONWIDE DUSSE 7.2 MJ/m ² athers.gov.au	Certificate no.: Assessor Name: Accreditation no. Certificate date: Dwelling Address 4 RETIMO STR BARDIA, NSW 2565 www.nathers.g	.: 20851 26 Apr 20 s: REET	Hassan
		ELEVATIONS (2	2)				
	Date 23/04/2019	Scale AS NOTED @ A3			ти по A106-	Revision A	
	_				_	_	

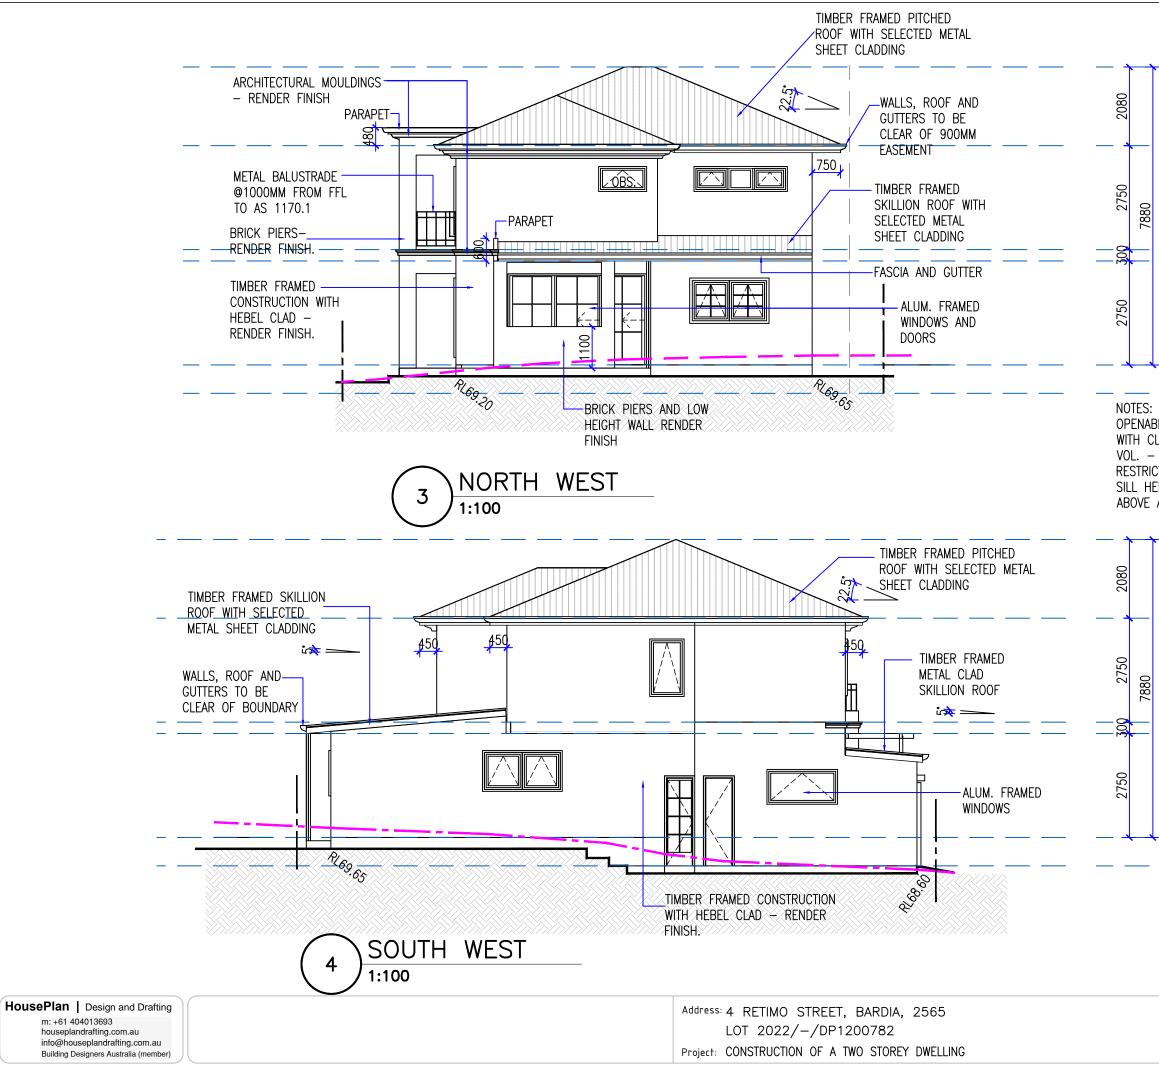



Mahbub Hassan



Drawing Title: S	ECTIONS		
Date	Scale	Drw no	Revision
23/04/2019	AS NOTED @ A3	A107	A

GROUND FLOOR

WINDOW SCHEDULE

	No.	SIZE		Hood	Sill	Style	
INC	0.	WD	HGT	Head	3111	Style AREA	
1		1500	2100	2300	200	STYLE a	3.15
2) -	2700	2100	2300	200	STYLE c	5.67
3	5	2100	1200	2300	1100	STYLE c	2.52
4	ł	2110	1080	2300	1220	Awning - double	2.321
5	;	1870	920	1800	880	Awning	1.683
6	5	850	920	2300	1380	Awning	.765

DOOR SCHEDULE

No.	SIZE		Style	Aroo
INO.	WD	HGT	Style	Area
1	1100	2100	Hinged — ENTRY a	2.31
2	3670	2400	STACKING – Triple –c	8.808
3	2440	2400	STACKING – Triple –b	5.856
4	800	2380	Hinged – Single – Full Lite (2)	1.904
5	1500	2400	Sliding - Double	3.6

FIRST FLOOR

WINDOW SCHEDULE

No.	SIZE		Head S	Sill	Stulo	AREA	
INO.	WD	HGT	пеац	311	Style		
101	1500	1800	2200	400	STYLE a	2.7	
102	1100	1800	2200	400	STYLE a	1.98	
103	1100	1800	2200	400	STYLE a	1.98	
104	1270	660	2200	1540	Awning	.826	
105	2470	660	2200	1540	2AWNING- 1FIX	1.606	
106	910	1520	2200	680	Awning	1.365	
107	1650	1500	2200	700	STYLE b	2.475	
108	1510	660	2200	1540	Awning	.982	

DOOR SCHEDULE

	No.	SIZE		Stude	A ====	
		WD	HGT	Style	Area	
-	101	2110	2100	Sliding – Double	4.431	
	102	920	2300	exterior 1	2.116	



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С	OLOUR S	ELECTION	
	LOCATION	COLOUR	SAMPLE
A	EXTERNAL WALLS AND MOULDINGS RENDER	TO MATCH DULUX NATURAL WHITE OR SIMILAR TO CLIENT'S SELECTION	
В	METAL SHEET ROOF CLADDING	COLORBOND WINDSPRAY OR SIMILAR TO CLIENT'S SELECTION	
С	GUTTER AND FASCIA	COLORBOND SURFMIST OR SIMILAR TO CLIENT'S SELECTION	
D	GARAGE DOORS	COLORBOND WINDSPRAY OR SIMILAR TO CLIENT'S SELECTION	
E	DECK AND PERGOLA	NATURAL TIMBER	
F	BALUSTRADE	BLACK POWDERCOATED	
G	WINDOW FRAMES	TO MATCH DULUX LEXICON QUARTER OR SIMILAR	
		Drawing Title: SCHEDULES	

	EXTERNAL	
	WALLS AN	
	MOULDING	
4	RENDER	

METAL	SHE
ROOF	
CLADDI	NG

	GUTTER	AN
С	FASCIA	

	LOCATION	COLOUR	SAMPLE
A	EXTERNAL WALLS AND MOULDINGS RENDER	TO MATCH DULUX NATURAL WHITE OR SIMILAR TO CLIENT'S SELECTION	
В	METAL SHEET ROOF CLADDING	COLORBOND WINDSPRAY OR SIMILAR TO CLIENT'S SELECTION	
С	GUTTER AND FASCIA	COLORBOND SURFMIST OR SIMILAR TO CLIENT'S SELECTION	
D	GARAGE DOORS	COLORBOND WINDSPRAY OR SIMILAR TO CLIENT'S SELECTION	
E	DECK AND PERGOLA	NATURAL TIMBER	
F	BALUSTRADE	BLACK POWDERCOATED	
G	WINDOW FRAMES	TO MATCH DULUX LEXICON QUARTER OR SIMILAR	

Date

Scale

23/04/2019 AS NOTED @ A3

Drw no

A110

Revision

А

Address: 4 RETIMO STREET, BARDIA, 2565 LOT 2022/-/DP1200782 Project: CONSTRUCTION OF A TWO STOREY DWELLING